

GAS MAIN EXTENSION NORTH PEMBROKE ROAD PEMBROKE, NEW HAMPSHIRE


PREPARED FOR:
LIBERTY UTILITIES
15 BUTTRICK ROAD
LONDONDERRY, NEW HAMPSHIRE 03053

PREPARED BY:
KEACH-NORDSTROM ASSOCIATES, INC.
10 COMMERCE PARK NORTH, SUITE 3
BEDFORD, NEW HAMPSHIRE 03110
(603) 627-2881

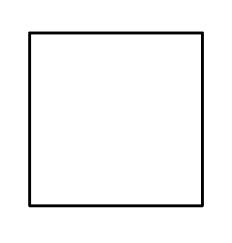

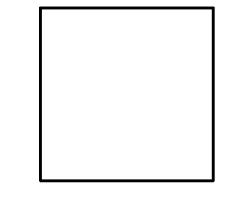



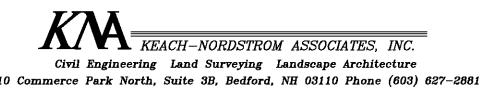


APRIL 2, 2019 PROJECT NO. 18-0910-1

SHEET	TITLE


GAS	MAIN	EXTENSION	OVERVIEW PLAN	1
GAS	MAIN	EXTENSION	LAYOUT PLAN	2 -
GAS	MAIN	EXTENSION	PROFILE PLAN	5
CONS	STRUC'	TION DETAIL	uS .	6 -

SHEET No.

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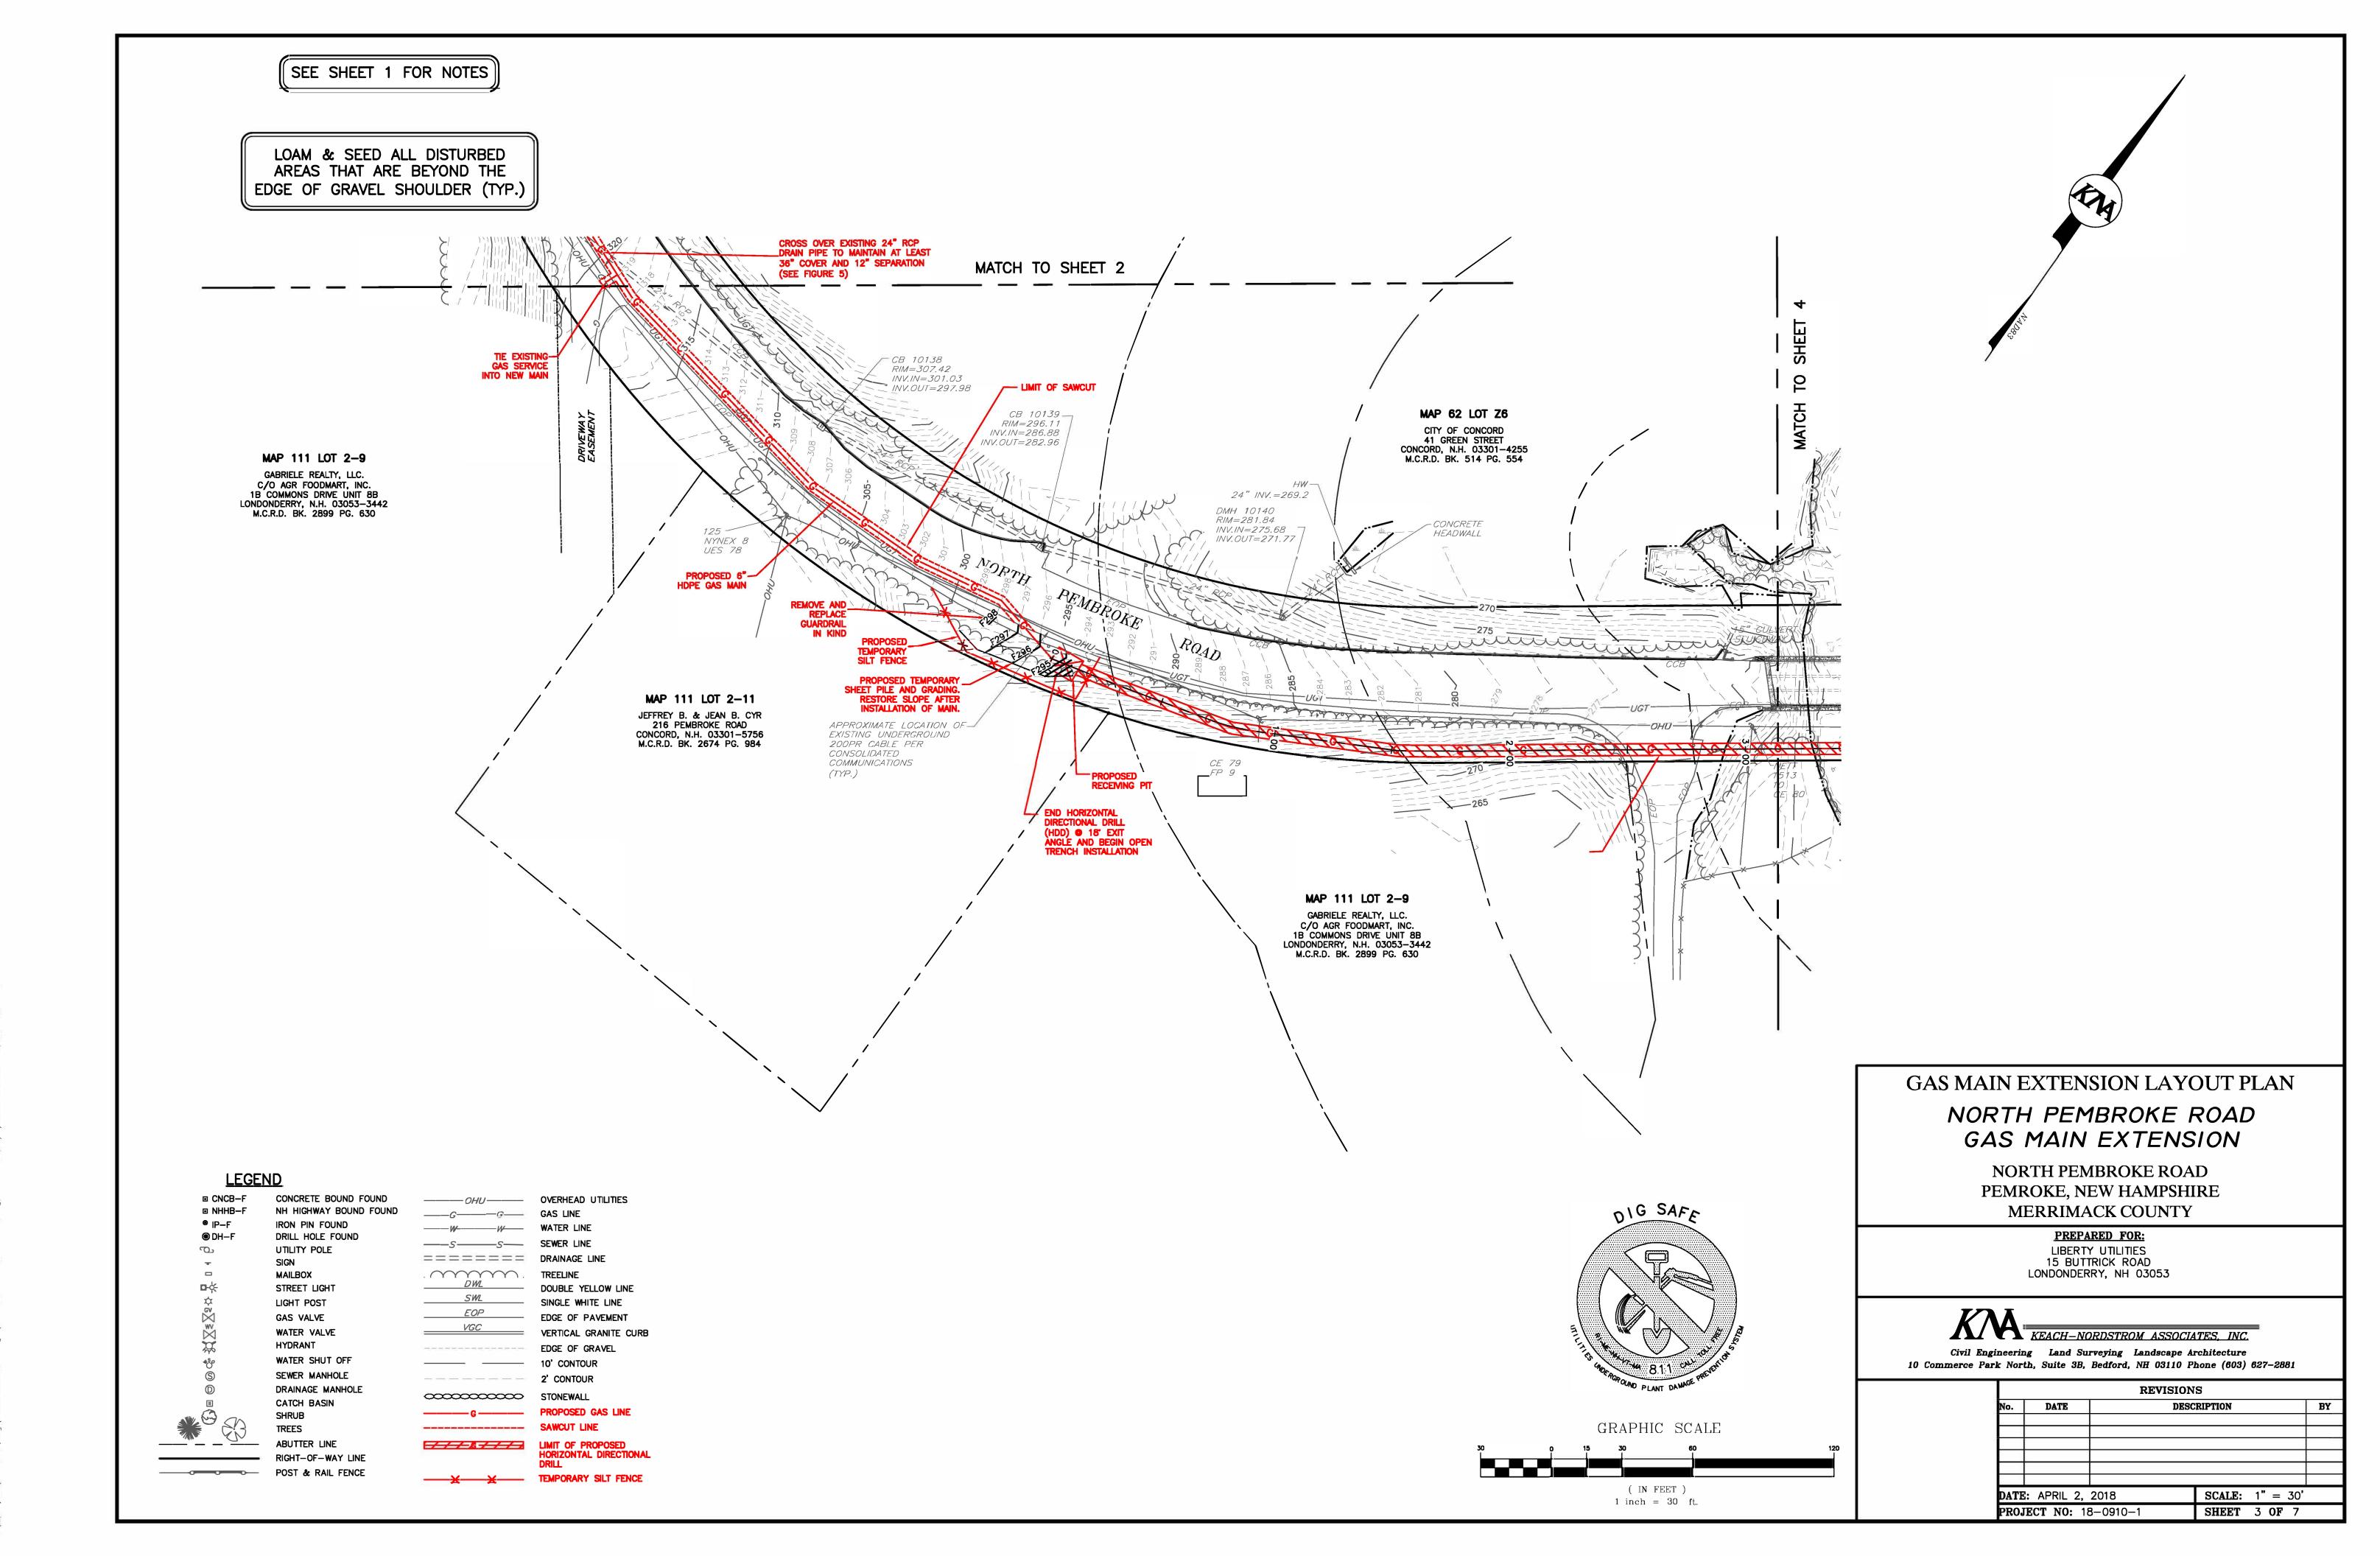

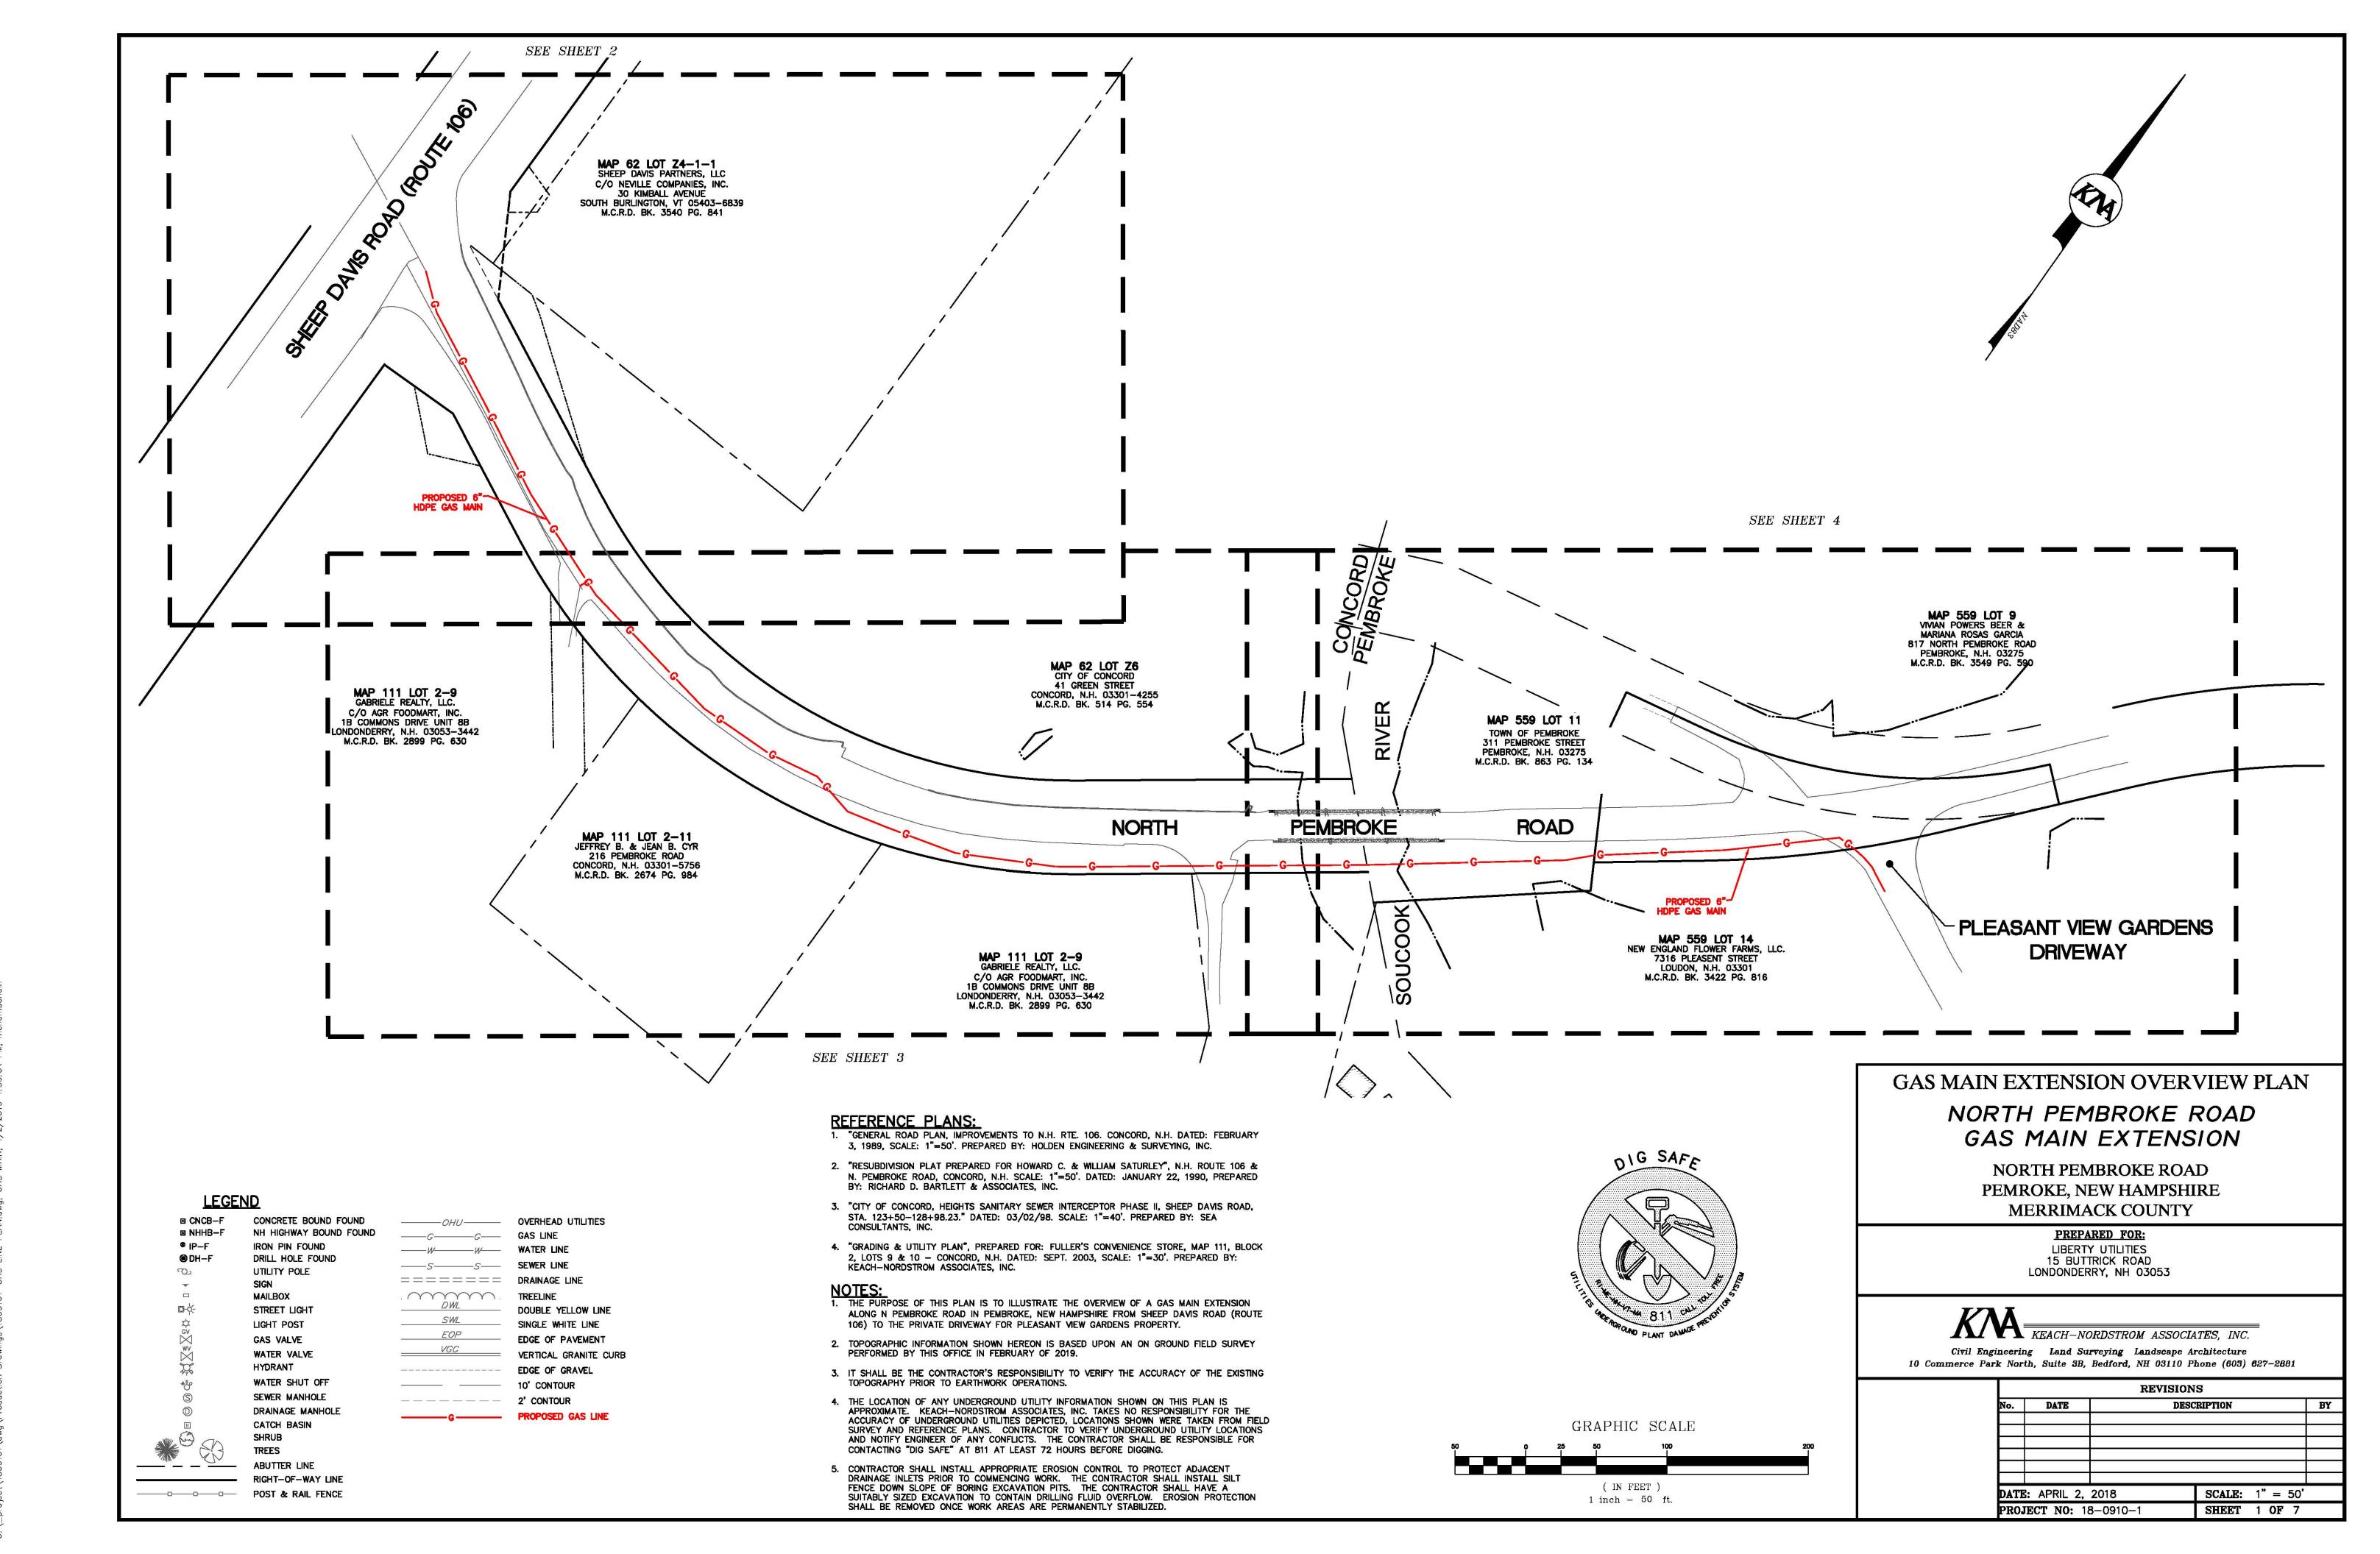
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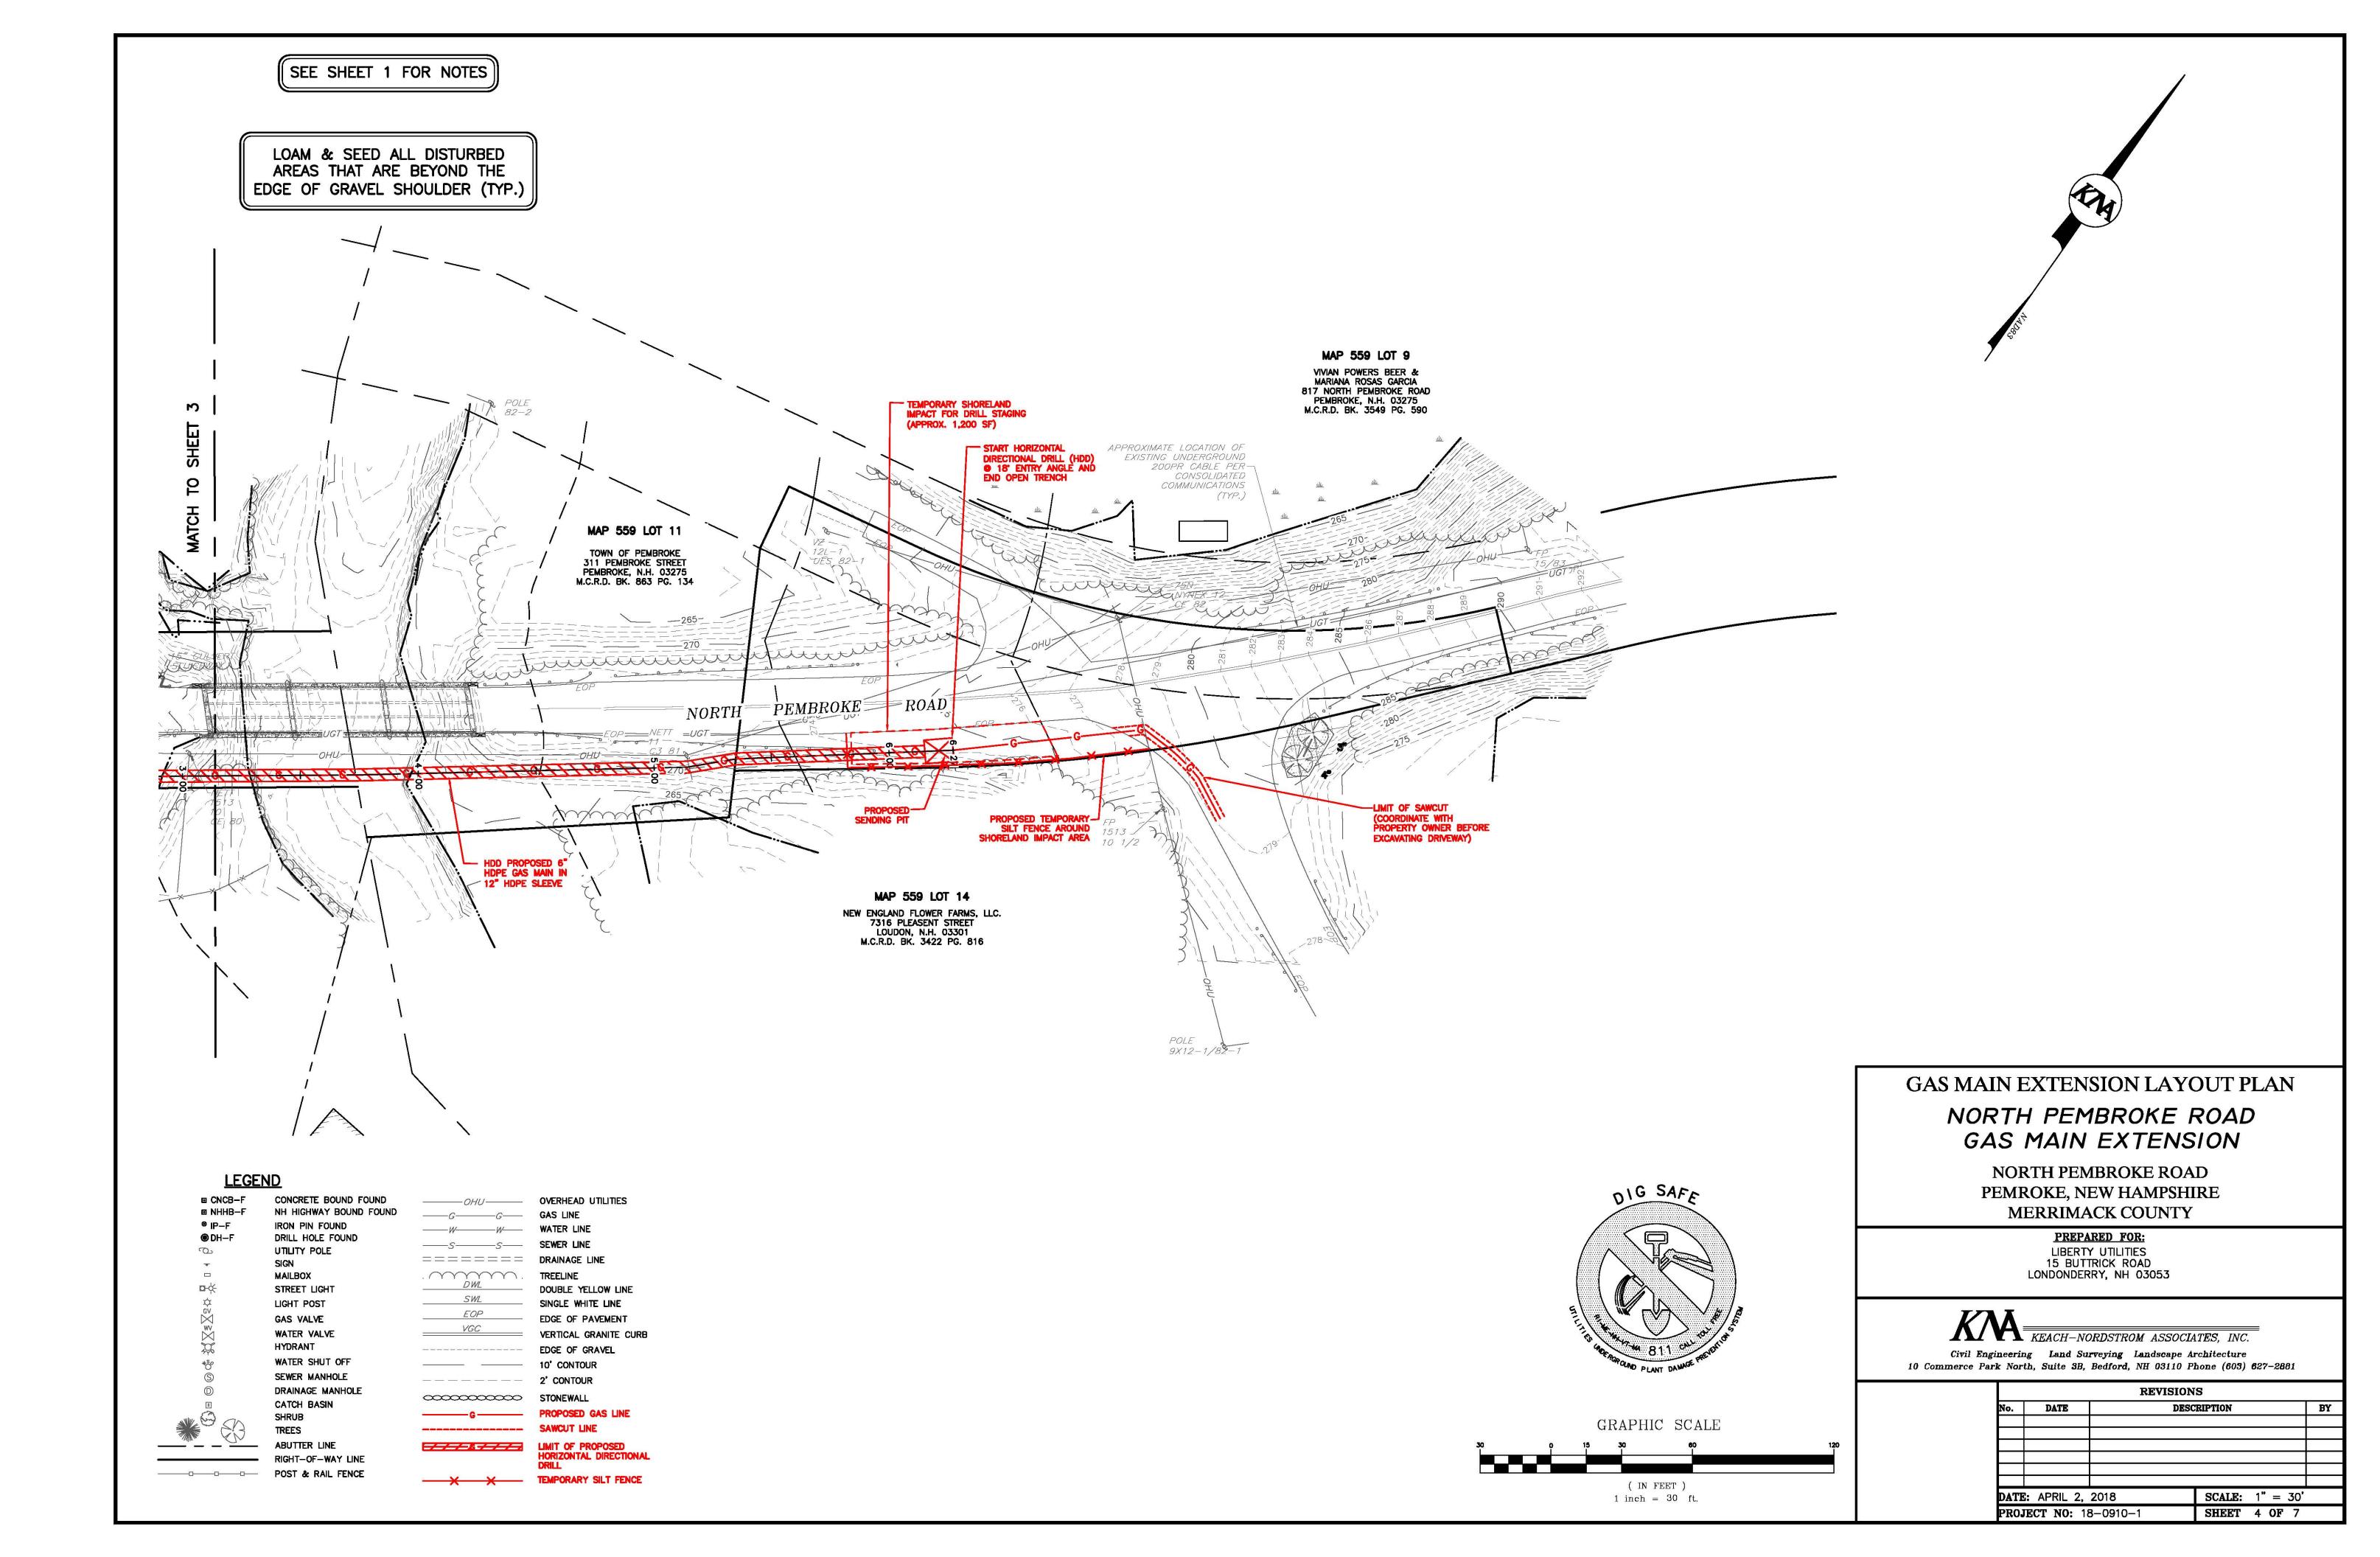


SEE SHEET 1 FOR NOTES

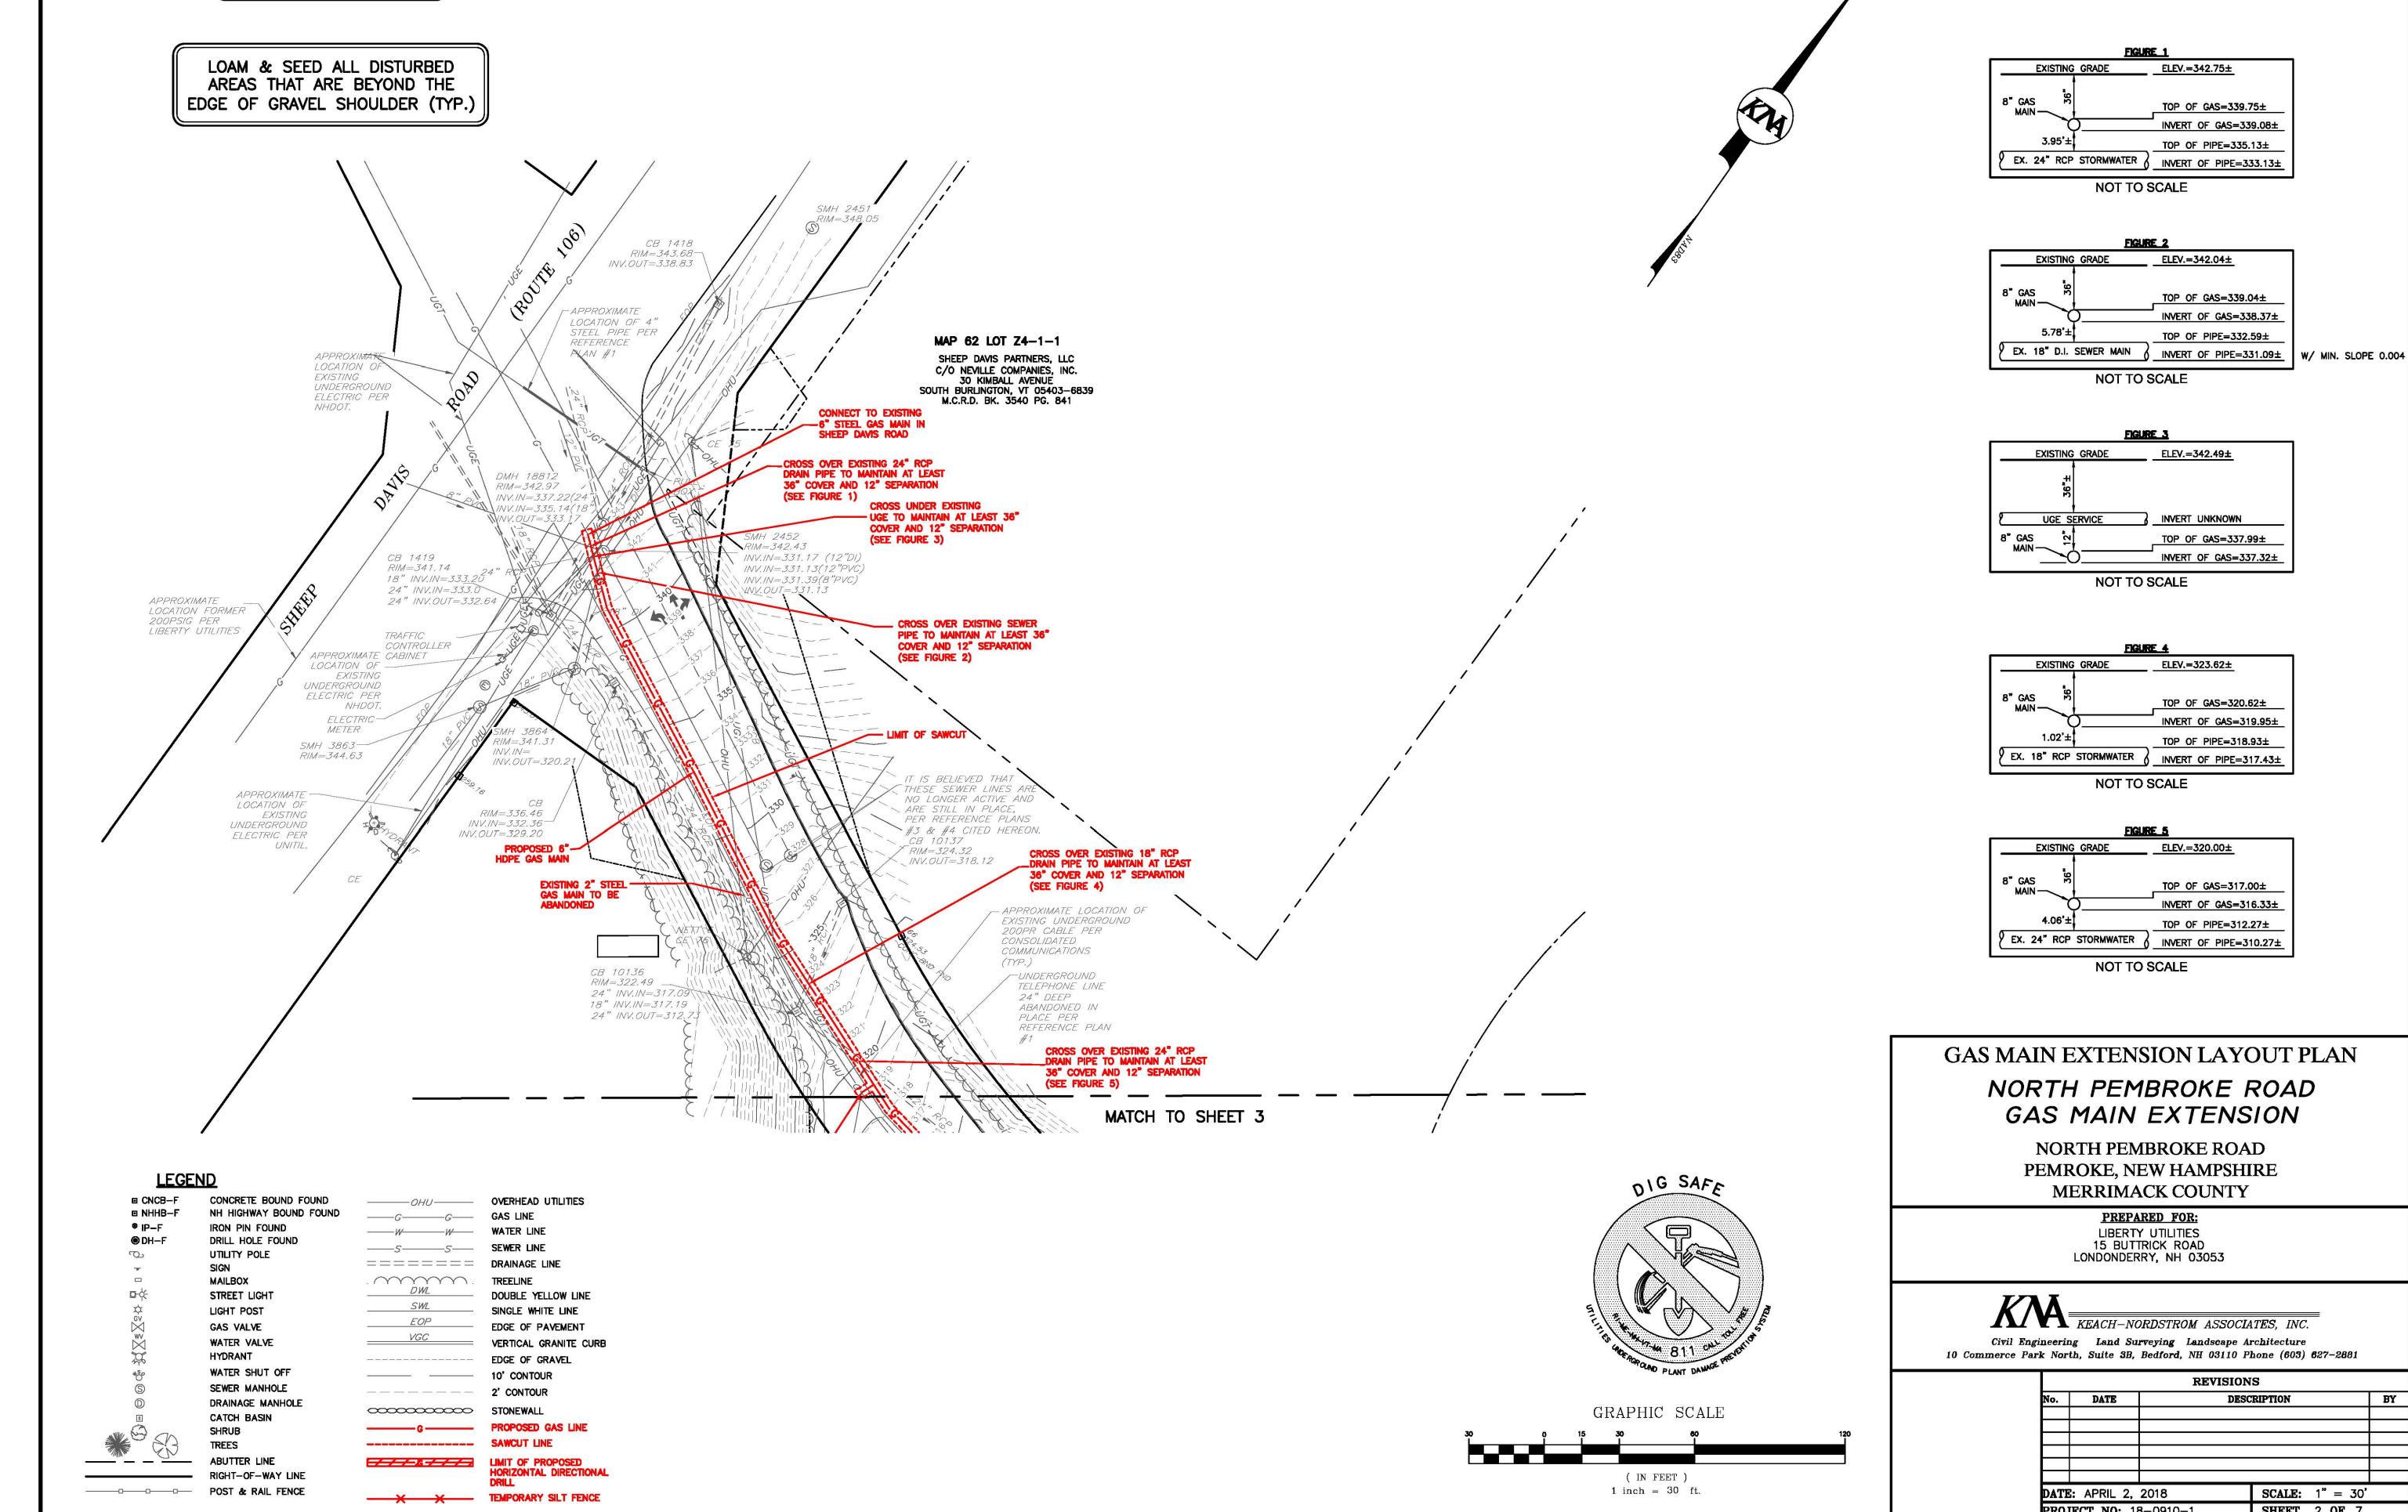
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۹o.	o. DATE DESCRIPTION				BY
DATE: APRIL 2, 2018 SCALE: 1" = 30'					
PROJECT NO: 18-0910-1 SHEET 2 OF 7					



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PROPOSED GAS MAIN HDD PROFILE

SCALE: 1" = 50'(HORIZ.)1" = 5'(VERT.)

_____S____S____SEWER LINE ===== DRAINAGE LINE DOUBLE YELLOW LINE SINGLE WHITE LINE

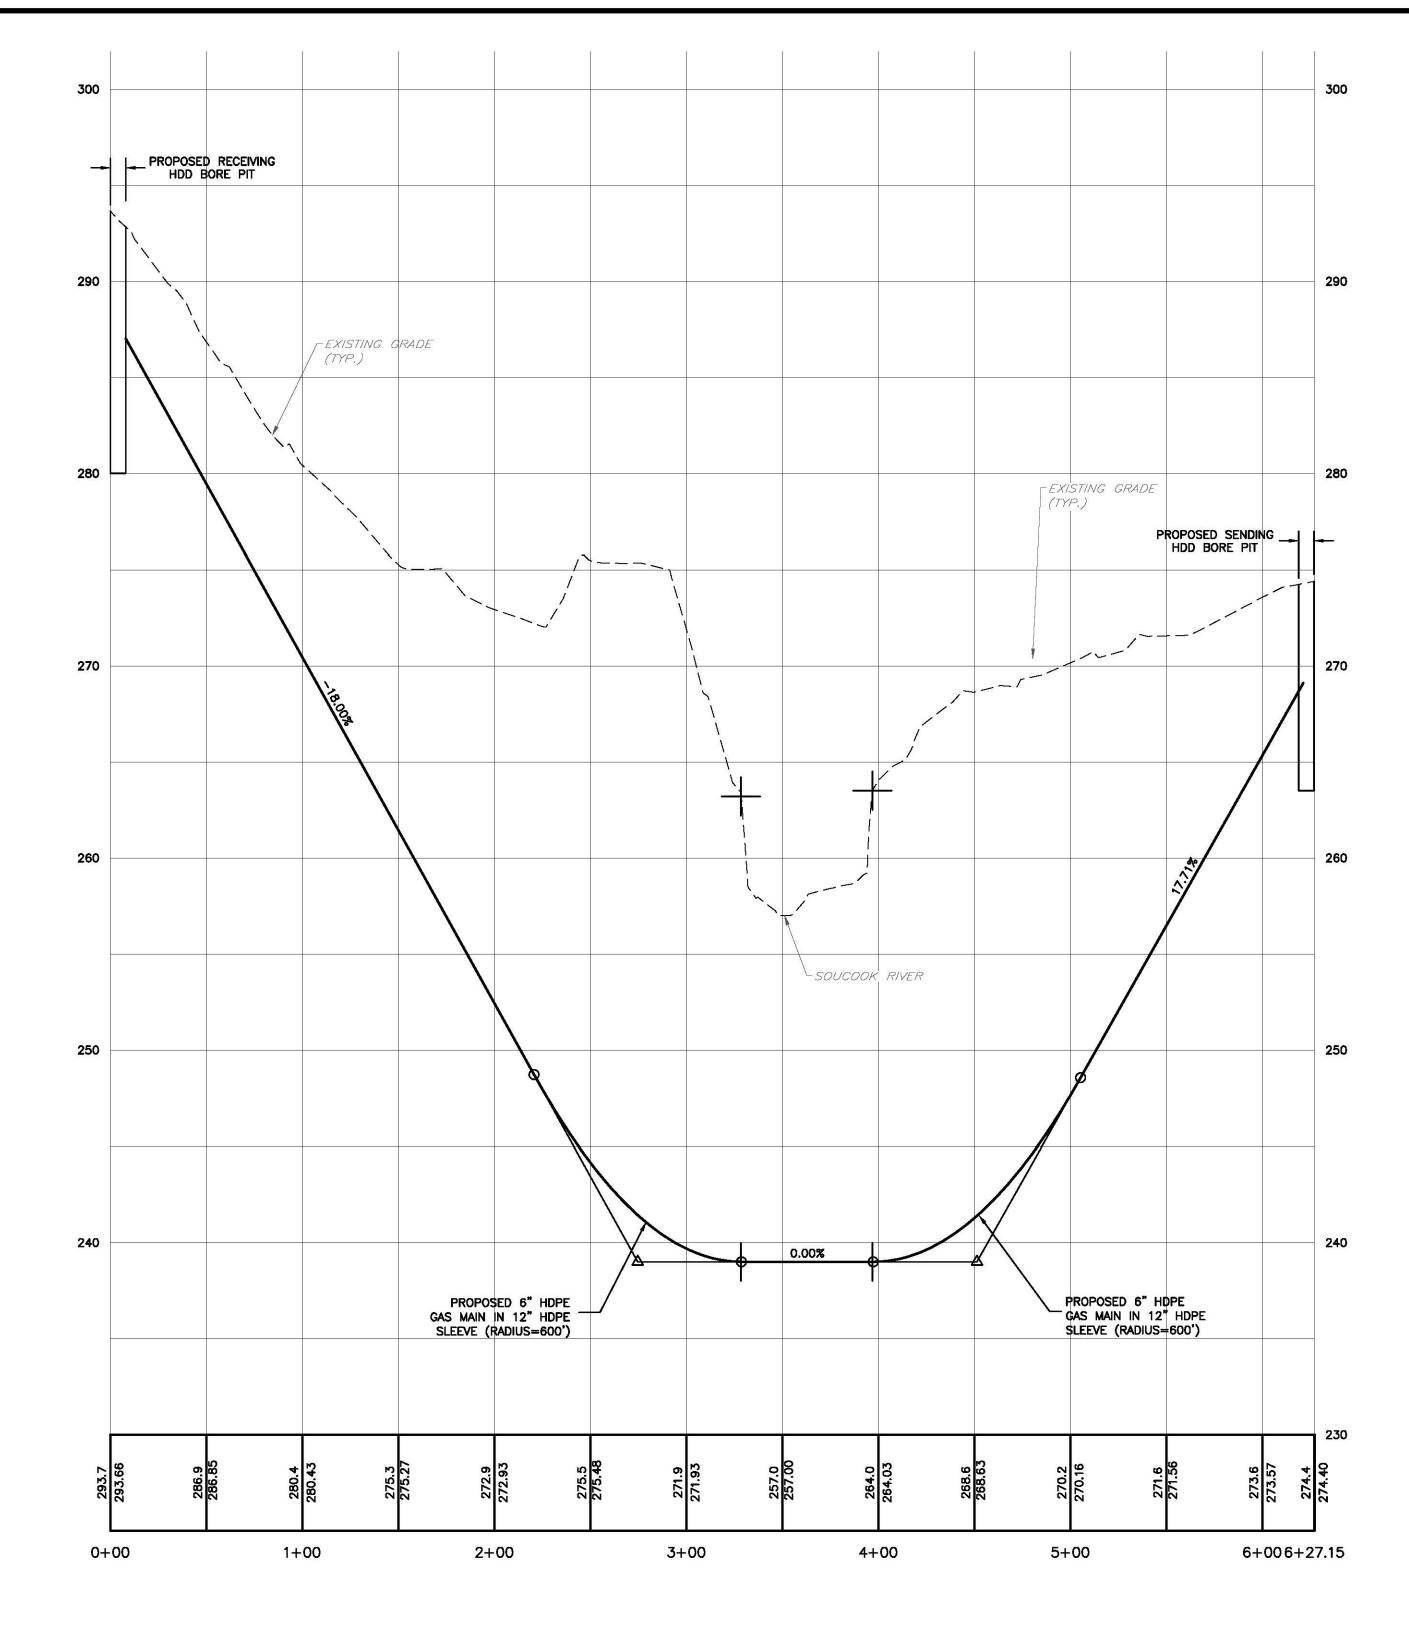WATER VALVE WATER SHUT OFF SEWER MANHOLE DRAINAGE MANHOLE ABUTTER LINE RIGHT-OF-WAY LINE

CONCRETE BOUND FOUND

IRON PIN FOUND

UTILITY POLE

STREET LIGHT

LIGHT POST

GAS VALVE

MAILBOX

DRILL HOLE FOUND

NH HIGHWAY BOUND FOUND

LEGEND

■ CNCB-F

® IP-F

POST & RAIL FENCE

EDGE OF PAVEMENT VERTICAL GRANITE CURB EDGE OF GRAVEL ______ 10' CONTOUR _____ 2' CONTOUR

-----OHU-----OVERHEAD UTILITIES



GAS MAIN EXTENSION PROFILE PLAN NORTH PEMBROKE ROAD GAS MAIN EXTENSION


NORTH PEMBROKE ROAD PEMROKE, NEW HAMPSHIRE MERRIMACK COUNTY

PREPARED FOR:
LIBERTY UTILITIES
15 BUTTRICK ROAD
LONDONDERRY, NH 03053


KEACH-NORDSTROM ASSOCIATES, INC. Civil Engineering Land Surveying Landscape Architecture 10 Commerce Park North, Suite 3B, Bedford, NH 03110 Phone (603) 627-2881


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DATE: APRIL 2, 2018 SCALE: AS NOTE)	
PROJECT NO: 18-0910-1 SHEET 5 OF 7						


TYPICAL GAS MAIN OPEN EXCAVATION TRENCH **NOT TO SCALE**

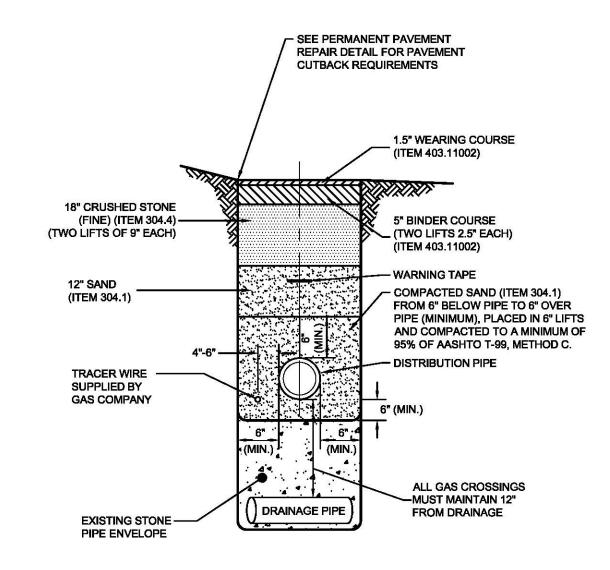

GAS MAIN OPEN EXCAVATION TRENCH IN ROADWAY NOT TO SCALE

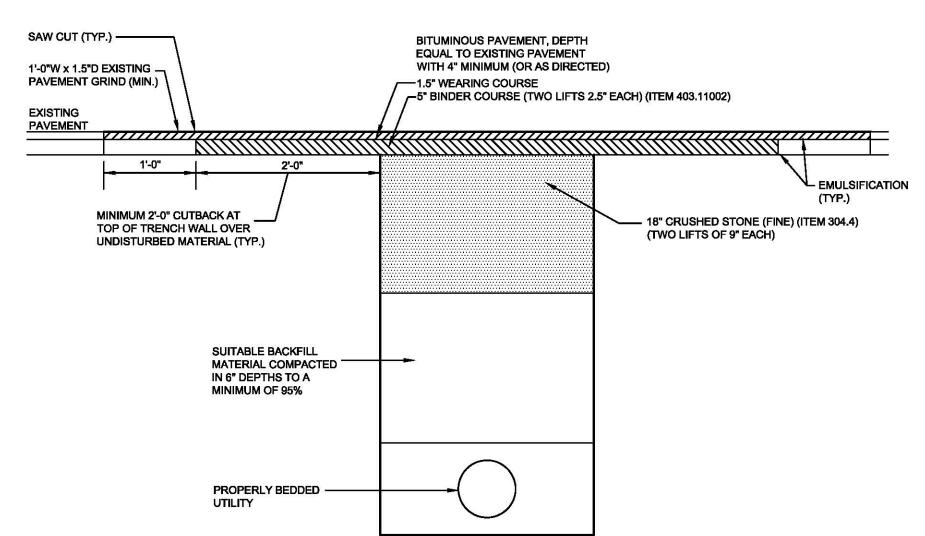

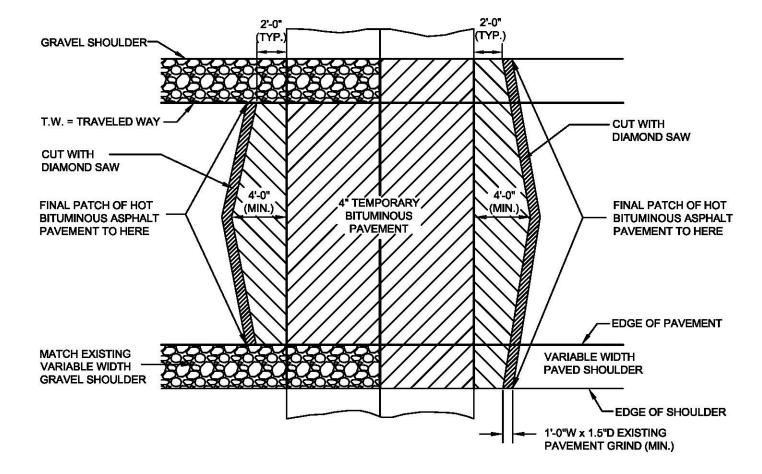

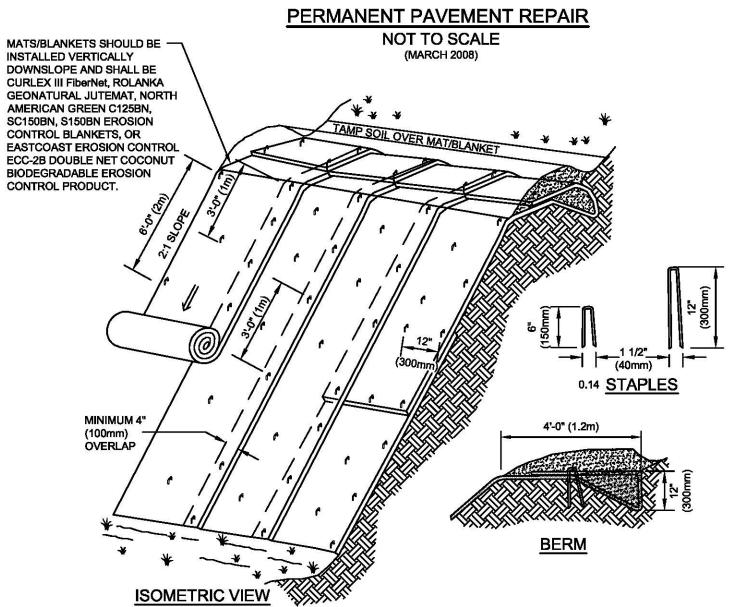


- 1. SLOPE SURFACE SHALL BE FREE OF ROCKS, CLODS, STICKS AND GRASS. MATS/ BLANKETS SHALL HAVE
- APPLY PERMANENT SEEDING BEFORE PLACING BLANKETS.
 LAY BLANKETS LOOSELY AND STAKE OR STAPLE TO MAINTAIN DIRECT CONTACT WITH THE SOIL. DO NOT
- 4. EROSION CONTROL BLANKETS WITH WELDED PLASTIC OR BIODEGRADABLE PLASTIC NETTING OR THREAD
- SHALL NOT BE USED.

 5. ACCEPTABLE EROSION CONTROL BLANKETS INCLUDE: CURLEX III FiberNet, ROLANKA GEONATURAL JUTEMAT, NORTH AMERICAN GREEN C125BN, SC150BN, S150BN EROSION CONTROL BLANKETS, OR EASTCOAST EROSION CONTROL ECC-2B DOUBLE NET COCONUT BIODEGRADABLE EROSION CONTROL PRODUCT.

(AUGUST 2011)

EROSION CONTROL BLANKETS - SLOPE INSTALLATION NOT TO SCALE

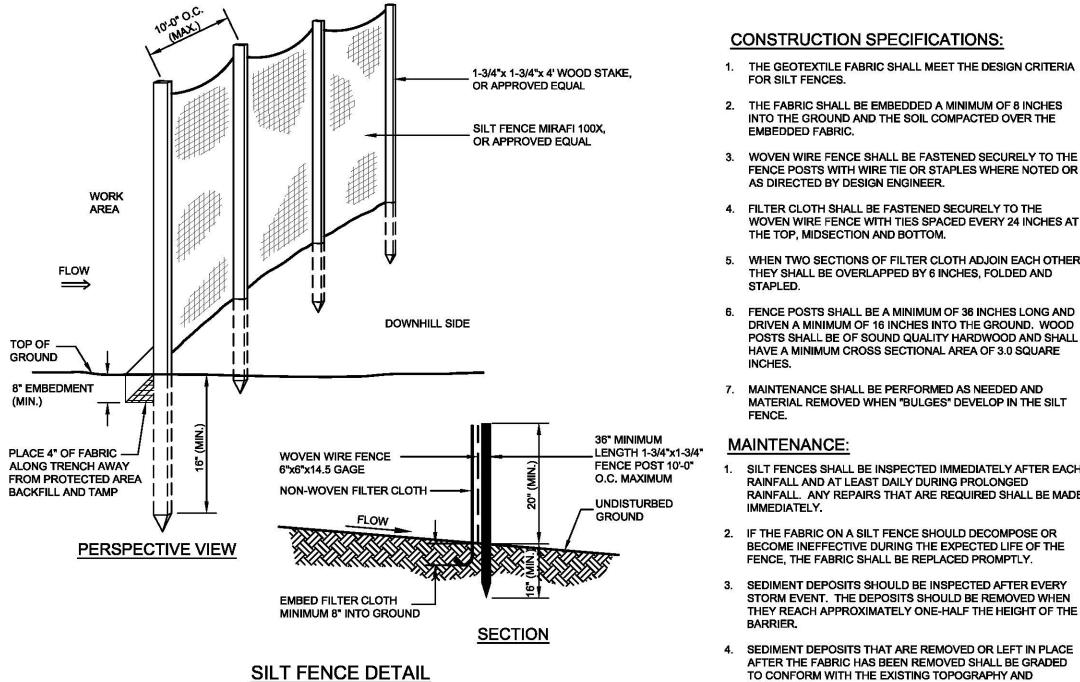

NOT TO SCALE

(MARCH 2008)

CONSTRUCTION SPECIFICATIONS: 1. THE GEOTEXTILE FABRIC SHALL MEET THE DESIGN CRITERIA FOR SILT FENCES. 2. THE FABRIC SHALL BE EMBEDDED A MINIMUM OF 8 INCHES

INTO THE GROUND AND THE SOIL COMPACTED OVER THE

FENCE POSTS WITH WIRE TIE OR STAPLES WHERE NOTED OR AS DIRECTED BY DESIGN ENGINEER. 4. FILTER CLOTH SHALL BE FASTENED SECURELY TO THE

WOVEN WIRE FENCE WITH TIES SPACED EVERY 24 INCHES AT THE TOP, MIDSECTION AND BOTTOM.

5. WHEN TWO SECTIONS OF FILTER CLOTH ADJOIN EACH OTHER, THEY SHALL BE OVERLAPPED BY 6 INCHES, FOLDED AND STAPLED.

6. FENCE POSTS SHALL BE A MINIMUM OF 36 INCHES LONG AND DRIVEN A MINIMUM OF 16 INCHES INTO THE GROUND. WOOD POSTS SHALL BE OF SOUND QUALITY HARDWOOD AND SHALL HAVE A MINIMUM CROSS SECTIONAL AREA OF 3.0 SQUARE

. MAINTENANCE SHALL BE PERFORMED AS NEEDED AND MATERIAL REMOVED WHEN "BULGES" DEVELOP IN THE SILT


MAINTENANCE

SILT FENCES SHALL BE INSPECTED IMMEDIATELY AFTER EACH RAINFALL AND AT LEAST DAILY DURING PROLONGED RAINFALL. ANY REPAIRS THAT ARE REQUIRED SHALL BE MADE IMMEDIATELY.

2. IF THE FABRIC ON A SILT FENCE SHOULD DECOMPOSE OR BECOME INEFFECTIVE DURING THE EXPECTED LIFE OF THE FENCE, THE FABRIC SHALL BE REPLACED PROMPTLY.

3. SEDIMENT DEPOSITS SHOULD BE INSPECTED AFTER EVERY STORM EVENT. THE DEPOSITS SHOULD BE REMOVED WHEN THEY REACH APPROXIMATELY ONE-HALF THE HEIGHT OF THE

4. SEDIMENT DEPOSITS THAT ARE REMOVED OR LEFT IN PLACE AFTER THE FABRIC HAS BEEN REMOVED SHALL BE GRADED TO CONFORM WITH THE EXISTING TOPOGRAPHY AND VEGETATED.

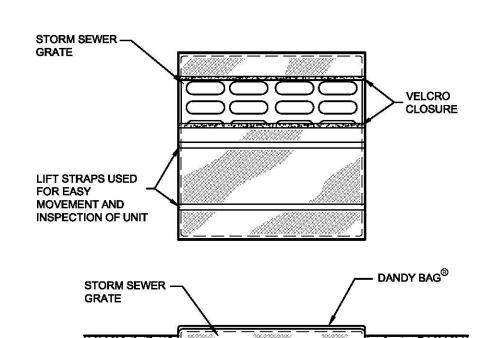

HI-FLOW DANDY BAG® (SAFETY ORANGE)

HI-FLOW DANDT BAG (SAFETT ORANGE)				
MECHANICAL PROPERTIES	TEST METHOD	UNITS	MARV	
GRAB TENSILE STRENGTH	ASTM D 4632	kN (lbs)	1.62 (365) x 0.89 (200)	
GRAB TENSILE ELONGATION	ASTM D 4632	%	24 x 10	
PUNCTURE STRENGTH	ASTM D 4833	kN (lbs)	0.40 (90)	
MULLEN BURST STRENGTH	ASTM D 3786	kPa (psi)	3097 (450)	
TRAPEZOID TEAR STRENGTH	ASTM D 4533	kN (lbs)	0.51 (115) x 0.33 (75)	
UV RESISTANCE	ASTM D 4355	%	90	
APPARENT OPENING SIZE	ASTM D 4751	Mm (US Std Sieve)	0.425 (40)	
FLOW RATE	ASTM D 4491	1/min/m ² (gal/min/ft ²)	5907 (145)	
DEDIAL TRADA	107110 4404		0.4	

DANDY BAG[®] NOT TO SCALE (APRIL 2010)


CONSTRUCTION DETAILS NORTH PEMBROKE ROAD GAS MAIN EXTENSION

NORTH PEMBROKE ROAD PEMROKE, NEW HAMPSHIRE MERRIMACK COUNTY

> PREPARED FOR: LIBERTY UTILITIES 15 BUTTRICK ROAD LONDONDERRY, NH 03053


▼ L KEACH-NORDSTROM ASSOCIATES, INC. Civil Engineering Land Surveying Landscape Architecture 10 Commerce Park North, Suite 3B, Bedford, NH 03110 Phone (603) 627-2881

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DATE	: APRIL 2,	2018	SCALE: AS SHO	OWN
PROJ	PROJECT NO: 18-0910-1 SHEET 6 OF 7			7

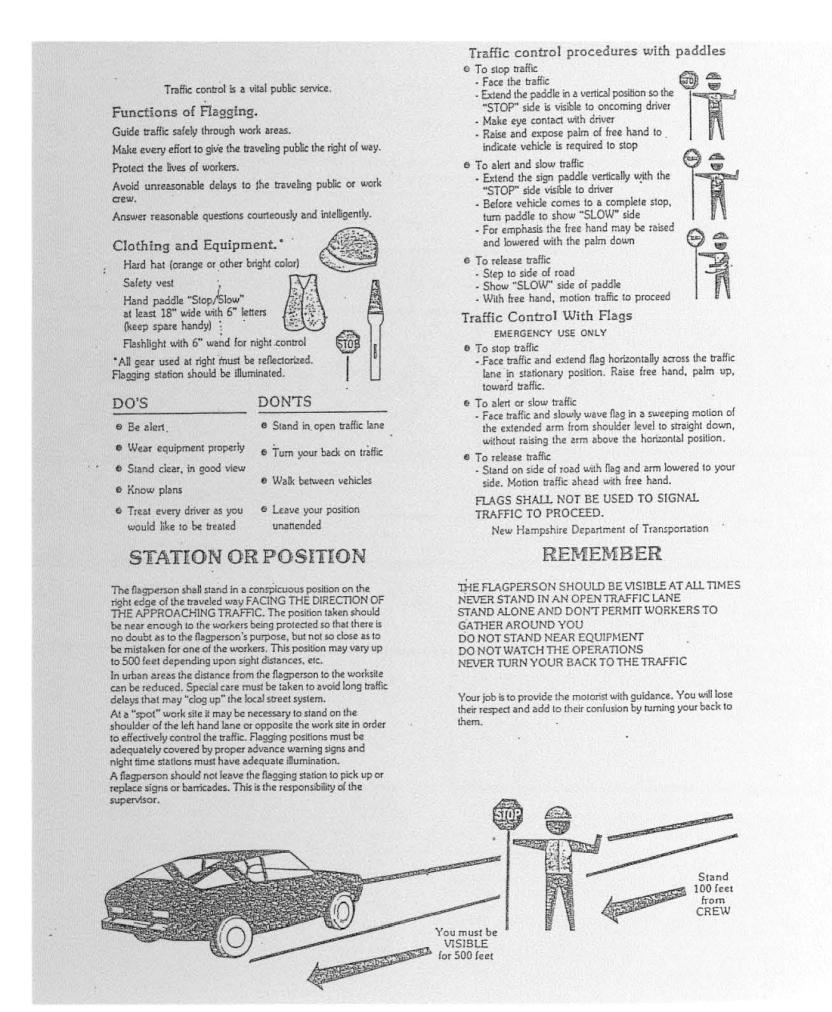

NHDOT DAYTIME TRAFFIC CONTROL PROCEDURE

NOT TO SCALE

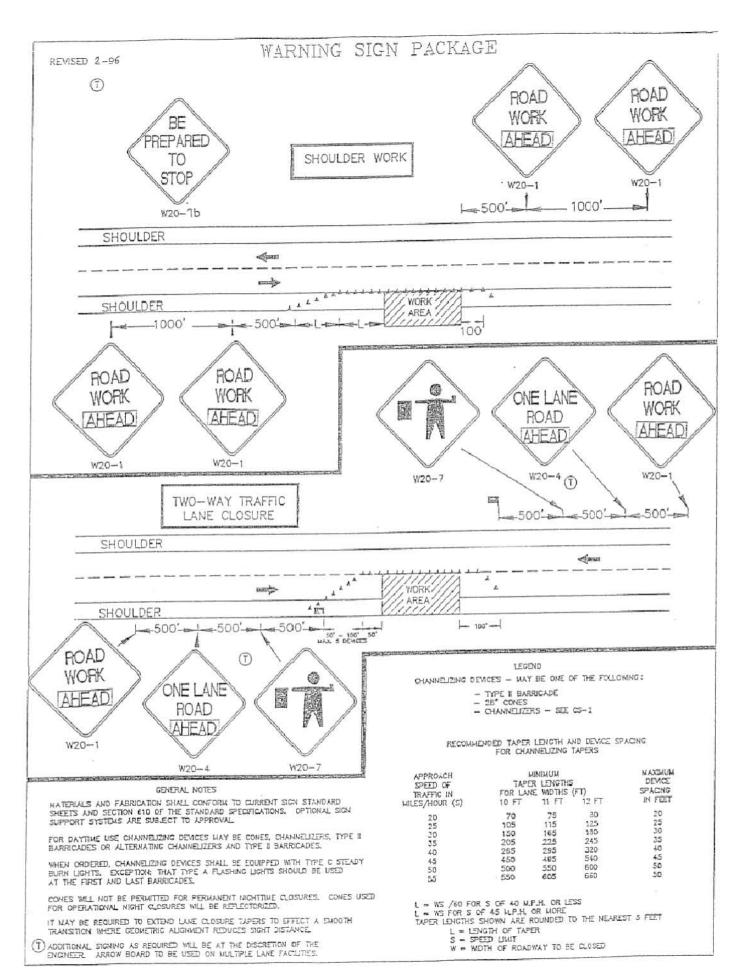

NHDOT WARNING SIGN PACKAGE DETAIL NOT TO SCALE

CONSTRUCTION DETAILS NORTH PEMBROKE ROAD GAS MAIN EXTENSION

NORTH PEMBROKE ROAD PEMROKE, NEW HAMPSHIRE MERRIMACK COUNTY

PREPARED FOR:
LIBERTY UTILITIES
15 BUTTRICK ROAD
LONDONDERRY, NH 03053

KEACH-NORDSTROM ASSOCIATES, INC.

Civil Engineering Land Surveying Landscape Architecture

10 Commerce Park North, Suite 3B, Bedford, NH 03110 Phone (603) 627-2861

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